



Architecture
Interior Design
Landscape Architecture
Engineering

222 North Second Street Long & Kees Bldg Suite 101 Minneapolis, MN 55401 612.339.3752

www.bkvgroup.com

CONSULTANTS



landscape architecture 5646 milton, suite 606 dallas, texas 75206 214.750.4727 www.garthoffdesign.com

PROJECT TITLE
SANDY CREEK

ISSUE # DATE DESCRIPTION #01 03/22/22 SITE PLAN

#01 03/22/22 SITE PLAN SUBMITTAL

CERTIFICATION



DRAWN BY
CHECKED BY
COMMISSION NUMBER
SHEET TITLE

LANDSCAPE KEY PLAN

XXXX-XXX

SHEET NUMBER


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LANDSCAPE RENOVATION NOTES:

- 1. LANDSCAPE IMPROVEMENTS SHOWN ON THESE DRAWINGS ARE DIAGRAMMATIC IN NATURE, BASED ON AVAILABLE INFORMATION AND SITE OBSERVATIONS. IT SHALL BE THE CONTRACTOR'S RESPONSIBILITY TO INSPECT THE SITE AND VERIFY EXISTING CONDITIONS. NOTIFY THE LANDSCAPE ARCHITECT IN WRITING OF ANY DISCREPANCIES OBSERVED ON SITE.
- 2. PLANT AND MATERIAL LOCATIONS AND QUANTITIES ARE APPROXIMATE, BASED ON SITE OBSERVATIONS. THE CONTRACTOR SHALL VERIFY EXISTING CONDITIONS AND MAKE MINOR MODIFICATIONS TO FIT ACTUAL SITE CONDITIONS AND COMPLY WITH DESIGN INTENT OF THE DRAWINGS.
- 3. REPAIR ALL ERODED AND WASHED OUT BARE SOIL AREAS WITHIN LAWN AND PLANTING BED AREAS. BACKFILL, FINE GRADE, ROLL AND RE-PLANT OR RE-SOD THESE AREAS TO SMOOTH OUT AND STABILIZE SOIL.
- 4. FINE GRADE AND RE-SOD ALL LAWN AREAS DISTURBED BY CONSTRUCTION ACTIVITY WITH SOLID SOD. ROLL SOD WITH 200 LB. WATER BALLAST TO LEVEL HIGH SPOTS AND CREATE COMPLETE CONTACT WITH SOIL BELOW.
- 5. REPLACE ANY PLANT MATERIALS DAMAGED BY CONSTRUCTION ACTIVITY WITH PLANTS OF SAME SPECIES AND QUANTITY.
- 6. EXERCISE EXTREME CAUTION WHEN WORKING IN THE VICINITY OF EXISTING TREES. PROTECT EXISTING TREES FROM DAMAGE AND COMPACTED SOIL WITHIN ROOT ZONES.
- 7. PROVIDE STEEL EDGING AS SHOWN ON PLANS AND BETWEEN ALL LAWN, PLANTING BED AND DECORATIVE GRAVEL AREAS.

LANDSCAPE IRRIGATION NOTES:


- 1. VISIT THE SITE TO INSPECT AND TEST EXISTING IRRIGATION SYSTEM PRIOR TO COMMENCEMENT OF CONSTRUCTION. NOTIFY THE OWNER IN WRITING OF ANY DAMAGED OR INOPERABLE IRRIGATION COMPONENTS IMMEDIATELY AND PRIOR TO CONSTRUCTION.
- 2. PROTECT EXISTING IRRIGATION SYSTEM AND MAINTAIN EXISTING IRRIGATION COVERAGE THROUGHOUT DURATION OF CONSTRUCTION ACTIVITY. MAKE REPAIRS OR MODIFICATIONS TO EXISTING IRRIGATION SYSTEM TO MAINTAIN EXISTING COVERAGE AND OPERATION.
- 3. PROVIDE 100% IRRIGATION COVERAGE TO ALL PLANTING AREAS USING AUTOMATIC, UNDERGROUND IRRIGATION SYSTEM.
- 4. SEE 'COORDINATION WITH EXISTING IRRIGATION'.
- 5. . IRRIGATION LAWN AREAS WITH W/ POP-UP SPRAYS / ROTORS (HUNTER PRS /PGP OR EQUAL).
- 6. IRRIGATE PLANTING BEDS AREAS WITH DRIP TUBING (NETAFIM O EQUAL).
- 7. IRRIGATE ALL TREES W/ BUBBLERS IN ACCORDANCE W/ CITY OF BRYAN REQUIREMENTS.
- 8. IRRIGATION PLANS SHALL BE SUBMITTED FOR SEPARATE PERMIT IN ACCORDANCE W/ CITY OF BRYAN REQUIREMENTS.

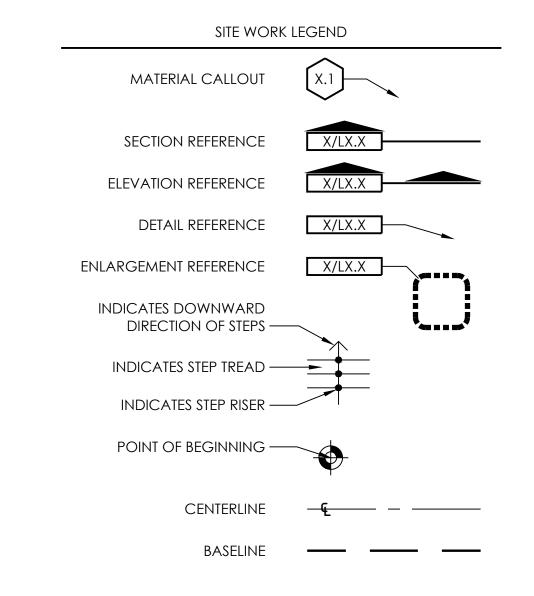

SITE WORK NOTES:

- 1. ALL DIMENSIONS ARE TAKEN PERPENDICULAR OR PARALLEL TO LINES UNLESS NOTED OTHERWISE.
- UNLESS NOTED OTHERWISE.

 2. ALL CONSTRUCTION SHALL BE LEVEL, PLUMB AND STRAIGHT UNLESS
- NOTED OTHERWISE.
- WRITTEN DIMENSIONS TAKE PRECEDENCE OVER SCALE.
 EXPANSION JOINTS SHALL BE LOCATED WHERE PAVEMENT ABUTS
 BUILDING, CURB, WALL OR OTHER VERTICAL SURFACE, AS INDICATED
 ON DRAWINGS AND ALONG RUNNING DIMENSION AT INTERVALS NOT
 MORE THAN 4 X WIDTH OF PAVEMENT. OWNER'S REPRESENATATIVE
 RESERVES THE RIGHT TO ADJUST QUANTITY AND LOCATION OF
 EXPANSION JOINTS PRIOR TO CONSTRUCTION.
- 5. CONTROL JOINTS SHALL BE LOCATED AS INDICATED ON DRAWINGS OR ALONG RUNNING DIMENSION AT INTERVALS NOT MORE THAN WIDTH OF PAVEMENT. OWNER'S REPRESENTATIVE RESERVES THE RIGHT TO ADJUST QUANTITY AND LOCATION OF CONTROL JOINTS PRIOR TO CONSTRUCTION.
- COORDINATE SITE WORK WITH OTHER SECTIONS OF LANDSCAPE DOCUMENTS AND WITH WORK OF OTHER DISCIPLINES.

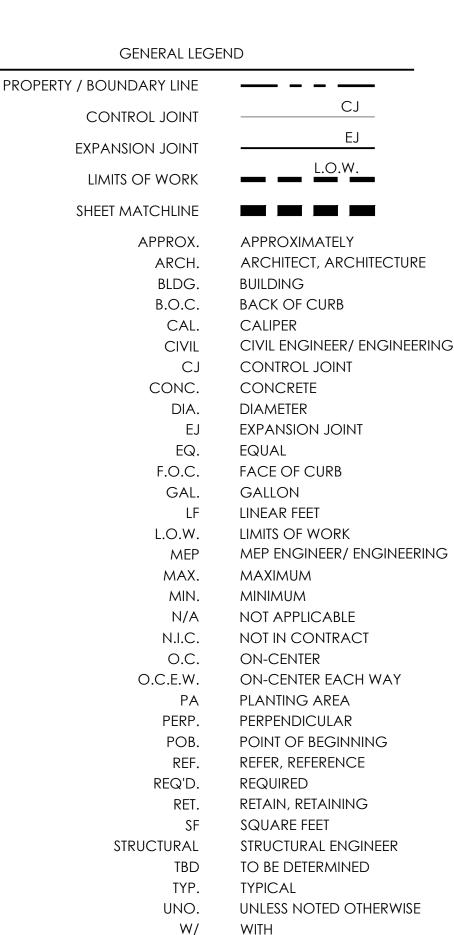

WITHOUT

GENERAL NOTES:

- 1. CONTRACTOR SHALL PROVIDE ALL MATERIALS AND LABOR TO
- COMPLETE SCOPE OF WORK AS INDICATED IN DOCUMENTS.

 2. ALL WORK SHALL BE EXECUTED IN ACCORDANCE WITH ALL FEDERAL, STATE AND LOCAL REGULATIONS, AND SHALL COMPLY WITH PREVAILING ACCESSIBILITY REQUIREMENTS. CONTRACTOR SHALL NOTIFY OWNER'S REPRESENTATIVE OF ANY PORTION OF DOCUMENTS
- WHICH CONFLICT WITH REGULATIONS PRIOR TO CONSTRUCTION.

 3. CONTRACTOR IS RESPONSIBLE FOR SECURING ALL REQUIRED PERMITS, APPROVALS AND INSPECTIONS RELATED TO SCOPE OF WORK.
- 4. CONTRACTOR IS RESPONSIBLE FOR NOTIFYING OWNER'S REPRESENTATIVE OF REQUESTED SITE VISITS OR INSPECTIONS SEVEN (7) DAYS IN ADVANCE OF WORK.
- 5. DRAWINGS ARE BASED ON SURVEY DATA AND DESIGN DRAWINGS
 PROVIDED BY OTHERS. IT IS THE CONTRACTOR'S RESPONSIBILITY TO
 VERIFY EXISTING CONDITIONS AND SHALL NOTIFY OWNER'S
 REPRESENTATIVE OF ANY DISCREPANCIES BETWEEN DOCUMENTS AND
 ACTUAL SITE CONDITIONS PRIOR TO CONSTRUCTION.
- 6. DO NOT PROCEED WITH ANY PORTION OF WORK AS INDICATED IN DOCUMENTS IF OBSTRUCTIONS, DISCREPANCIES OR UNKNOWN CONDITIONS ARE ENCOUNTERED. NOTIFY OWNER'S REPRESENTATIVE IMMEDIATELY FOR DIRECTION ON HOW TO PROCEED.
- 7. CONTRACTOR SHALL COORDINATE ALL WORK WITH OTHER DISCIPLINES AND TRADES.
- 8. LIMITS OF WORK INDICATED ON DRAWINGS, IF ANY, ARE GENERAL IN NATURE AND ARE INTENDED TO DEFINE THE GENERAL VICINITY IN WHICH THE SCOPE OF WORK EXISTS. ACTUAL LIMITS OF WORK SHALL INCLUDE ALL AREAS NECESSARY TO COMPLETE SCOPE OF DESIGN INTENT.
- 9. REFERENCE TO "OWNER'S REPRESENTATVE" IS MADE IN THESE DOCUMENTS, AND REFERS TO THE PROJECT OWNER OR DESIGNATED REPRESENTATIVE. IN ADDITION TO THE OWNER'S REPRESENTATIVE, THE CONTRACTOR SHALL CONTACT THE LANDSCAPE ARCHITECT FOR DESIGN CLARIFICATIONS OR ADDITIONAL INFORMATION RELATED TO SCOPE OF WORK.
- 10. UNLESS OTHERWISE NOTED, ALL EXISTING TREES SHALL BE PROTECTED. DO NOT PARK, DRIVE, OPERATE MACHINERY OR STORE MATERIALS WITHIN THE DRIPLINE OF EXISTING TREES.

WARRANTY:

1. CONTRACTOR SHALL WARRANTY ALL MATERIALS, PLANTS AND WORKMANSHIP FOR A PERIOD OF ONE (1) YEAR, TO COMMENCE UPON OWNER'S ACCEPTANCE OF SUBSTANTIAL COMPLETION.

PLANTING LEGEND PLANT CALLOUT: INDICATES SPECIES --- ABC INDICATES QUANTITY -PLANT MIX CALLOUT: INDICATES % OF MIX — ► 50% INDICATES SPECIES ABC NDICATES QUANTITY 123 INDICATES QUANTITY — **CANOPY TREE** (CENTER SYMBOL VARIES) -ACCENT TREE (CENTER SYMBOL VARIES) -SHRUB/ORNAMENTAL GRASS (CENTER SYMBOL VARIES) — PERENNIAL (CENTER LETTER VARIES) ———(A) BED LINE (INDICATES SEPARATION OF SPECIES - NO EDGING) STEEL EDGING _____

PLANTING NOTES:

- ALL NON-DIMENSIONED PLANT SYMBOLS, EDGING AND BED LINES ARE DIAGRAMMATIC AND SHALL BE SCALED FROM DRAWINGS.
- 2. STAKE ALL PROPOSED TREE LOCATIONS ON FINISH GRADE WITH DIFFERENT COLOR FLAGS FOR REVIEW AND APPROVAL BY OWNER'S REPRESENTATIVE PRIOR TO EXCAVATION. THE OWNER'S REPRESENTATIVE RESERVES THE RIGHT TO MAKE MINOR ADJUSTMENTS TO TREE LOCATIONS PRIOR TO EXCAVATION.
- 3. PAINT OR STRING ALL EDGING AND BED LINE LOCATIONS ON FINISH GRADE FOR REVIEW AND APPROVAL BY OWNER'S REPRESENTATIVE PRIOR TO INSTALLATION. THE OWNER'S REPRESENTATIVE SHALL RESERVE THE RIGHT TO MAKE MINOR ADJUSTMENTS TO LAYOUT OF PLANTING AREAS PRIOR TO EXCAVATION.
- 4. TREES SHALL BE PLANTED NO CLOSER THAN 4' TO PAVEMENT, CURB, EDGING, WALL OR UTILITIES UNLESS NOTED OTHERWISE.
- 5. TREES SHALL BE PLANTED NO CLOSER THAN 10' TO ANY STRUCTURE OR OVERHEAD UTILITY.6. TREES OVERHANGING PEDESTRIAN AND VEHICULAR PAVEMENTS ARE INTENDED TO HAVE
- A MINIMUM CLEAR-TRUNK BRANCHING HEIGHT OF 7' AT MATURITY.

 7. TREES OVERHANGING VISIBILITY EASEMENTS OR RIGHTS-OF-WAY ARE INTENDED TO HAVE
- A MINIMUM CLEAR-TRUNK BRANCHING HEIGHT OF 9' AT MATURITY.
- 8. ALL TREES, LAWN AND PLANTING AREAS TO RECEIVE 100% IRRIGATION COVERAGE FROM AUTOMATIC UNDERGROUND IRRIGATION SYSTEM UNLESS NOTED OTHERWISE.
- FINISH GRADE SHALL BE APPROVED BY OWNER'S REPRESENTATIVE PRIOR TO PLANTING.
 ANY QUANTITIES PROVIDED ON PLANS OR SCHEDULES ARE FOR INFORMATION AND CONTRACTOR CONVENIENCE ONLY. CONTRACTOR IS RESPONSIBLE FOR QUANTITY
- TAKE-OFFS AND SHALL PROVIDE FULL COVERAGE OF PLANTING AREAS AS INDICATED IN DRAWINGS.
 11. ALL PLANTS SHALL MEET SIZE AND QUALITY SPECIFICATIONS AS INDICATED IN DOCUMENTS AND SHALL BE OF TOP QUALITY, VIGOROUS, HEALTHY CONDITION. THE
- OWNER'S REPRESENTATIVE RESERVES THE RIGHT TO REJECT PLANTS NOT MEETING SPECIFICATIONS.

 12. ALL NEW PLANTS SHALL BE FERTILIZED W/ SLOW-RELEASE GRANULES FORMULATED FOR
- NEW PLANTINGS, USED IN ACCORDANCE W/ MANUFACTURER'S RECOMMENDATIONS.

 13. COORDINATE PLANTING WITH OTHER SECTIONS OF LANDSCAPE DOCUMENTS AND WITH
- WORK OF OTHER DISCIPLINES.

 14. PROVIDE EDGING AS SHOWN ON SCHEDULE AT THE EDGE OF ALL PLANTING BEDS.

 15. UNLESS NOTED OTHERWISE, THE FOLLOWING SOIL AMENDMENT PROCEDURES SHALL BE
- FOLLOWED, USING PRODUCTS BY <u>SOIL BUILDING SYSTEMS</u>, DALLAS, TEXAS OR APPROVED EQUAL:
- A. COMPLETELY ERADICATE ALL WEEDS FROM LAWN AND PLANTING AREAS PRIOR TO BEGINNING SOIL PREPARATION. ALL IMPORT SOILS SHALL BE 98% FREE FROM WEEDS.
 B. TREES: BACKFILL TREE PITS WITH 50/50 MIXTURE OF NATIVE TOPSOIL AND "TREE MIX".
- C. <u>BEDDING PLANTS, 1 GALLON OR SMALLER</u>: EXCAVATE OR LEAVE LOW TO DEPTH OF 4", TILL TO DEPTH OF 4", BACKFILL W/ 4" OF "PH-BALANCED COMPOST", THEN TILL TO FULLY INCORPORATE TO DEPTH OF 8".
- D. <u>BEDDING PLANTS, LARGER THAN 1 GALLON</u>: EXCAVATE OR LEAVE LOW TO DEPTH OF 7", TILL TO DEPTH OF 7", BACKFILL W/ 7" OF "PH-BALANCED COMPOST", THEN TILL TO FULLY INCORPORATE TO DEPTH OF 14".
- E. LAWN AREAS: SPREAD 2" OF NATIVE STRIPPED OR IMPORTED TOPSOIL OVER CLEAN, FRIABLE, LIGHTLY-SCARIFIED GRADE. PROVIDE TEMPORARY COVERAGE OF ANNUAL RYE SHOULD THE TEMPERATURE NOT PERMIT COVERAGE OF LAWN TYPE SHOWN IN PLANT SCHEDULE.
- F. MULCH ALL PLANTING BEDS WITH CONTINUOUS MINIMUM 2" LAYER OF FINE-SHREDDED HARDWOOD MULCH.

MAINTENANCE AND ESTABLISHMENT:

- 1. CONTRACTOR TO PROVIDE TEMPORARY MAINTENANCE AND ESTABLISHMENT OF PLANTING AND IRRIGATION, TO COMMENCE IMMEDIATELY UPON COMPLETION OF ANY PORTION OF WORK AND EXTENDING FOR PERIOD OF 90 DAYS AFTER OWNER'S ACCEPTANCE OF SUBSTANTIAL COMPLETION.
- MAINTENANCE AND ESTABLISHMENT SERVICES SHALL INCLUDE, BUT ARE NOT LIMITED TO: MOWING, TRIMMING, BLOWING, TRASH PICK-UP, MULCHING, WEEDING, FERTILIZATION, ADJUSTMENT/RE-SETTING OF PLANTS, STAKES, GUYS, ADJUSTMENT AND PROGRAMMING OF IRRIGATION, PRUNING AND CORRECTIVE WORK.
- 3. CONTRACTOR SHALL REMOVE STAKES, GUYS AND OTHER TEMPORARY ESTABLISHMENT MEASURES AT CONCLUSION OF 1-YEAR WARRANTY OR OTHER AGREED-UPON TIME.



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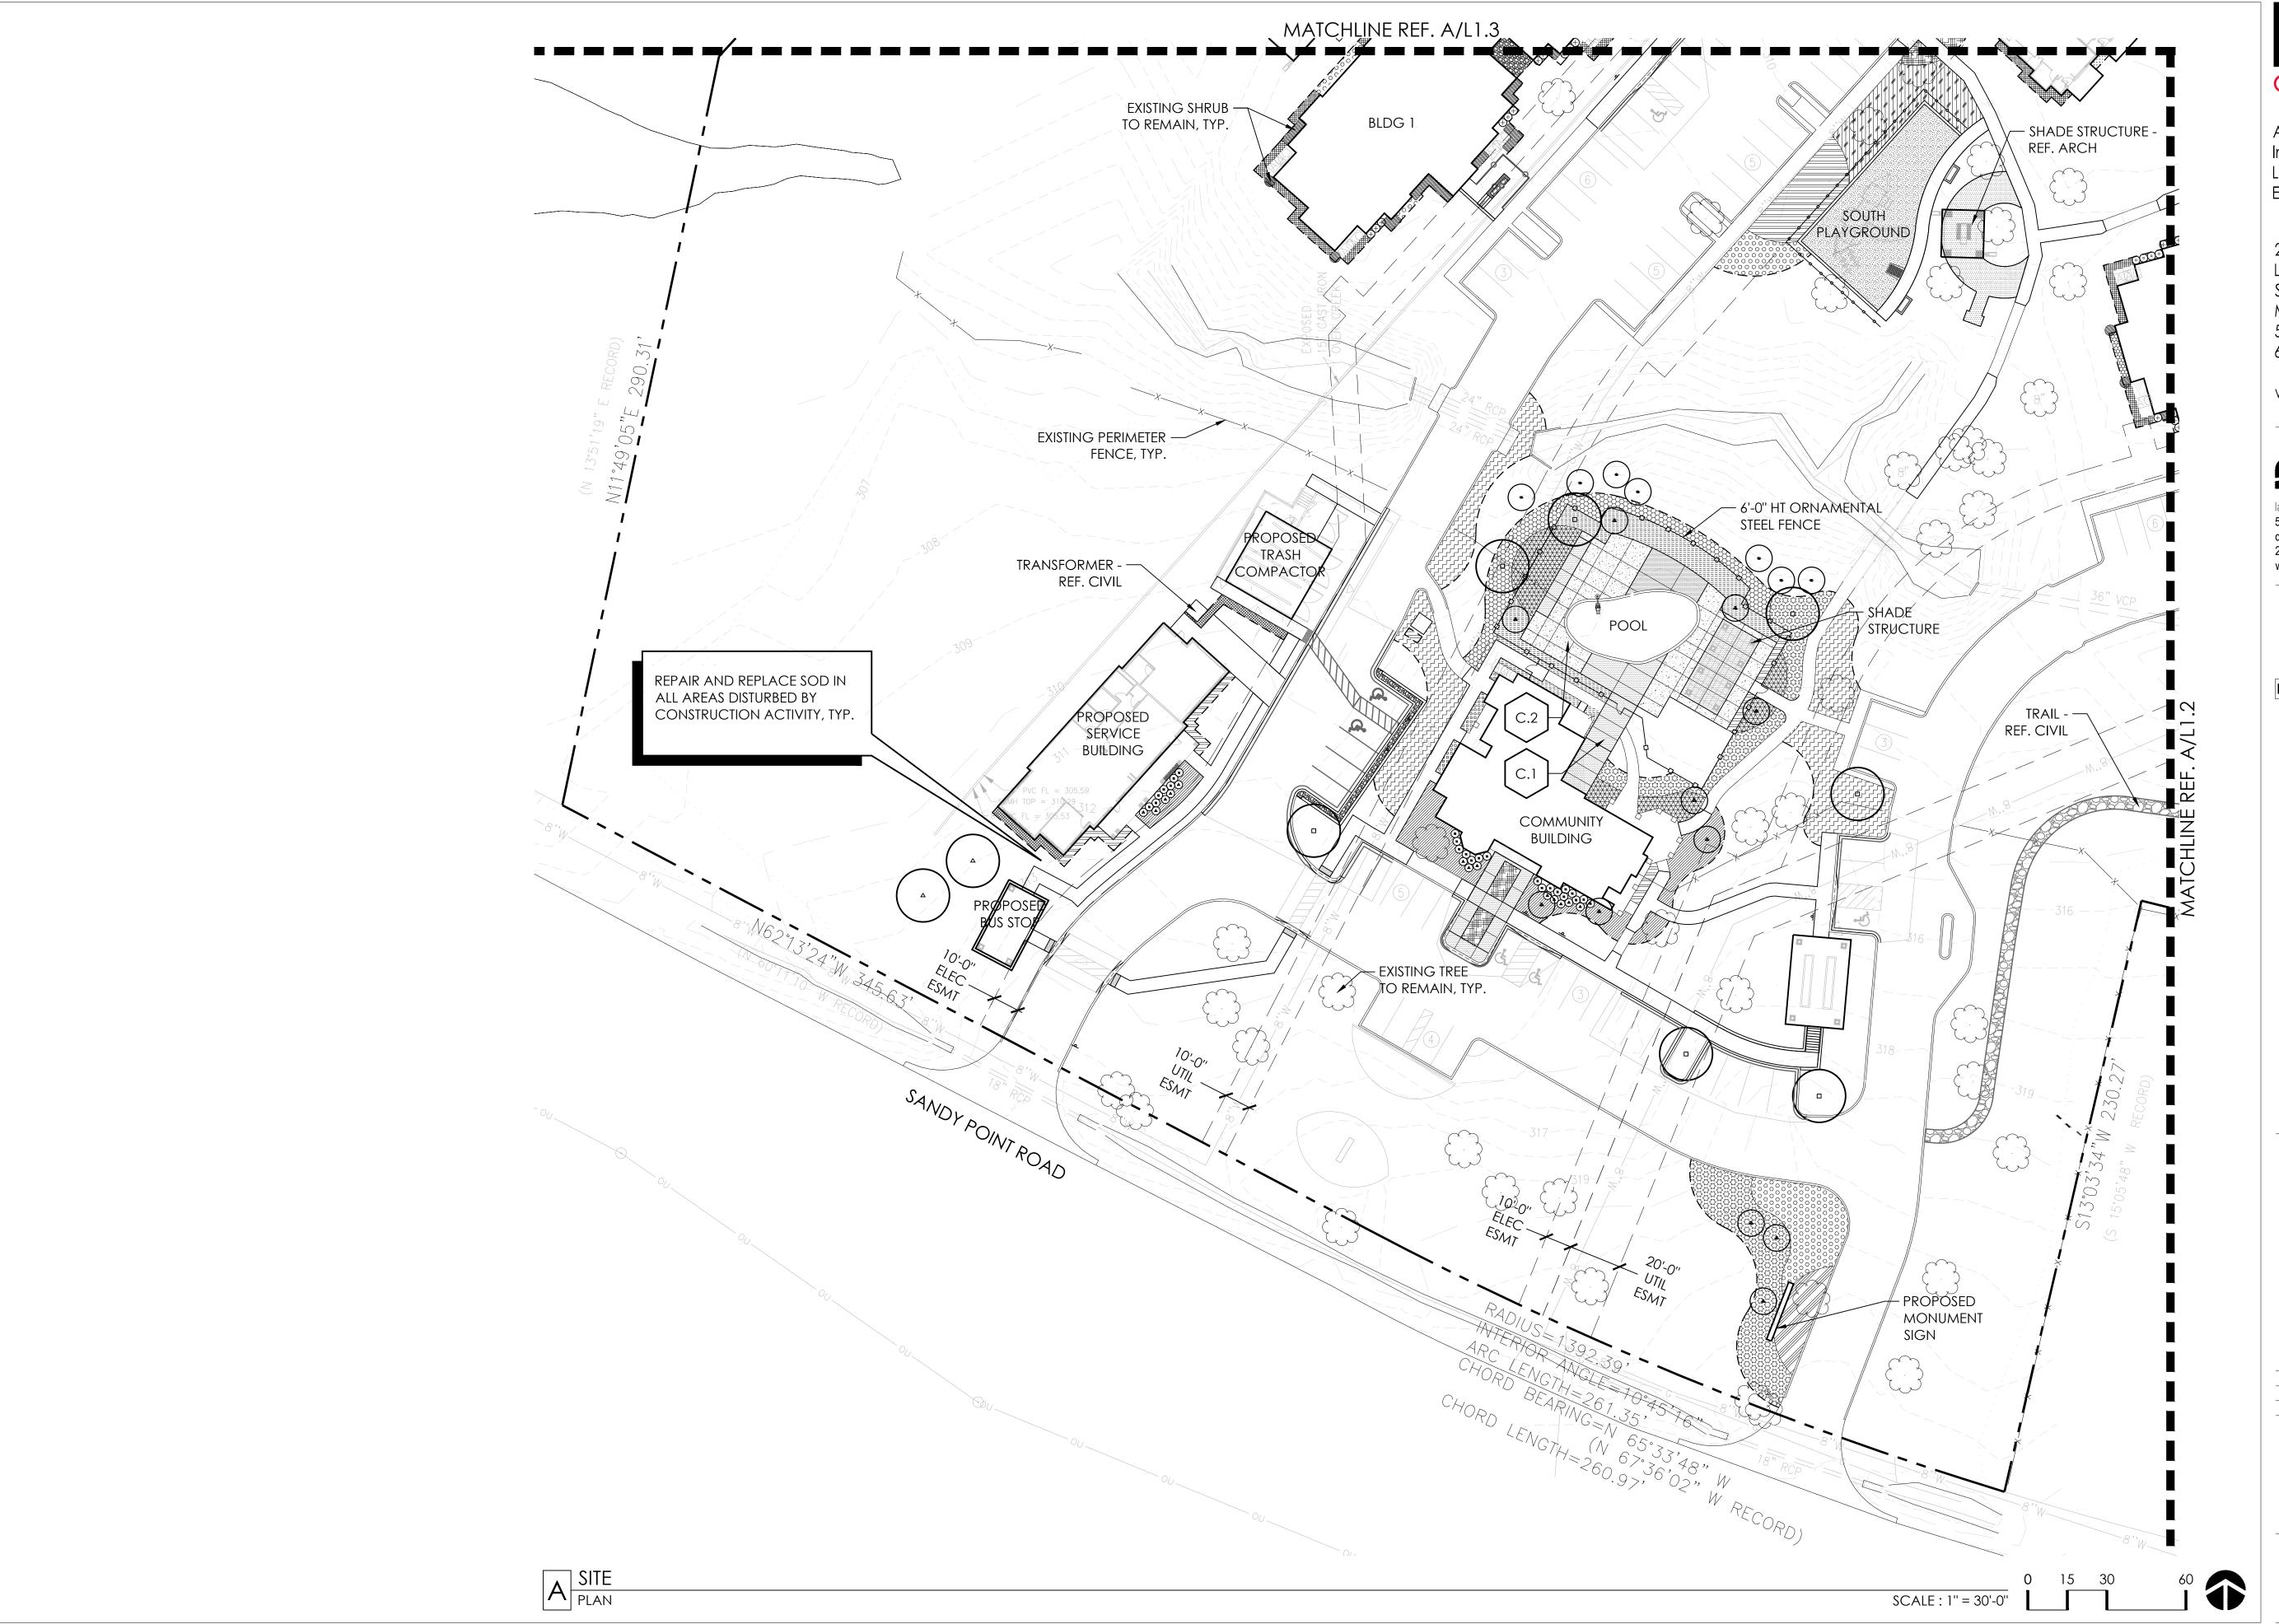
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LANDSCAPE NOTES & LEGENDS

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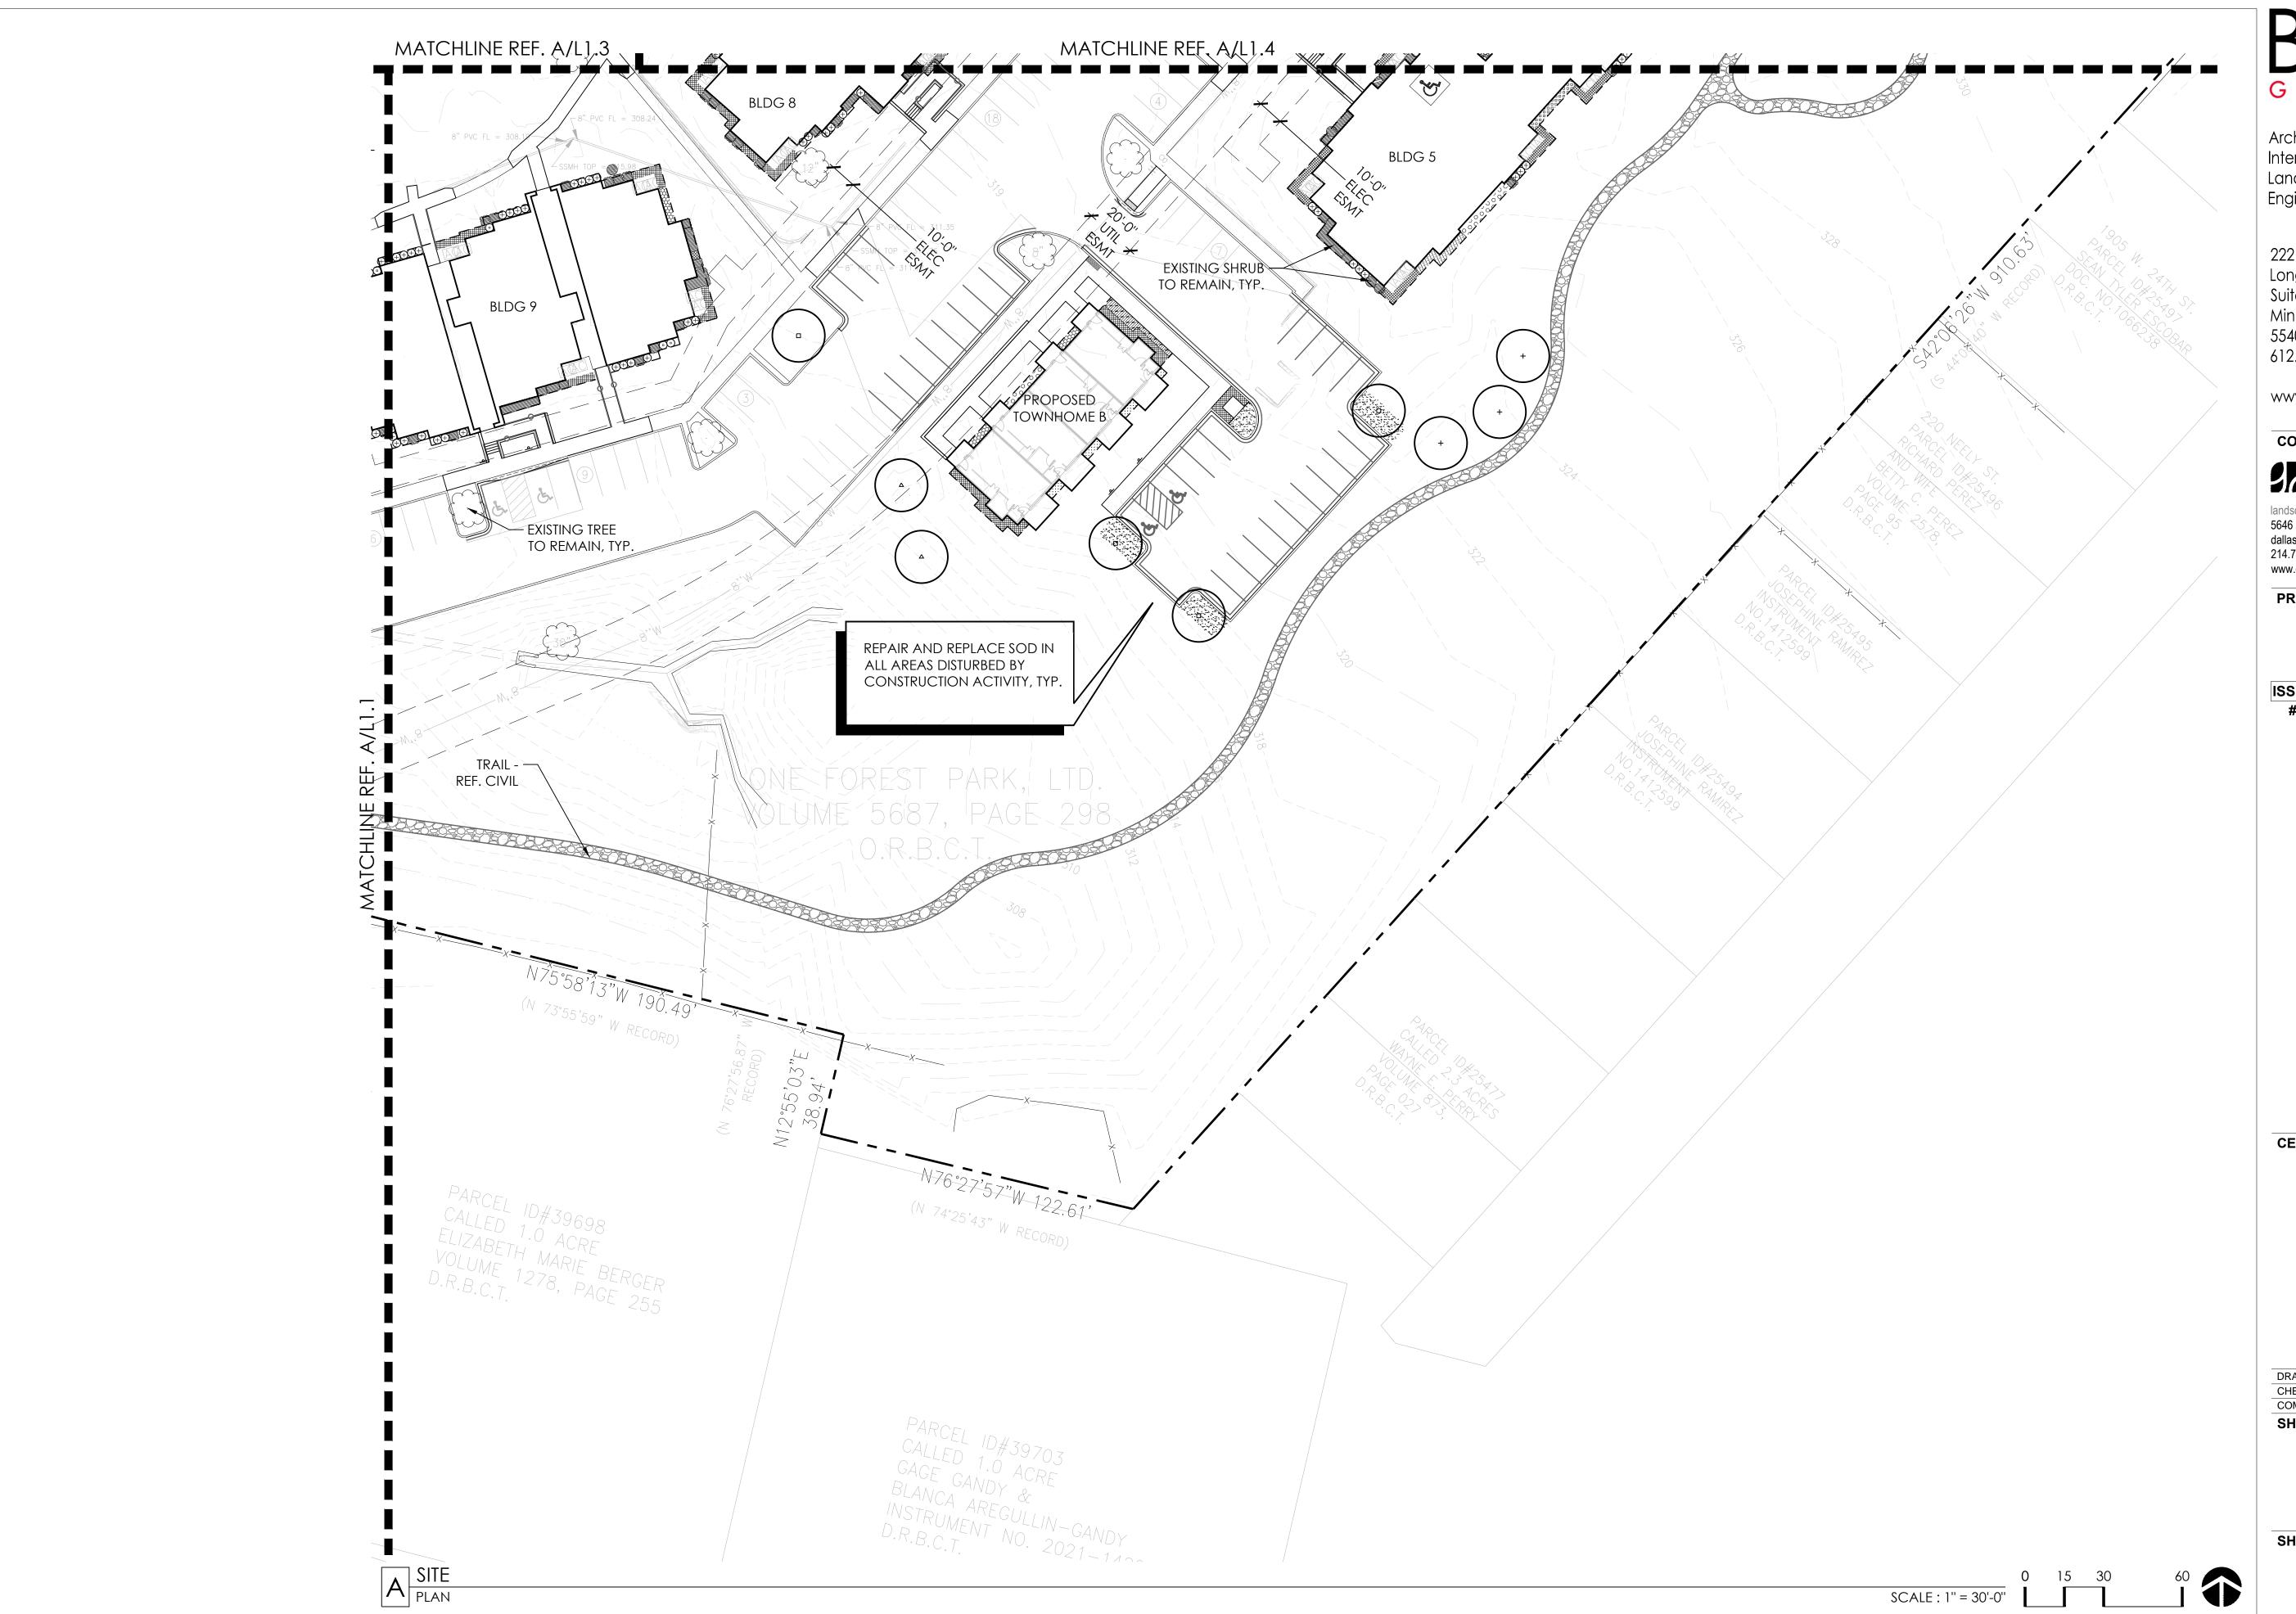
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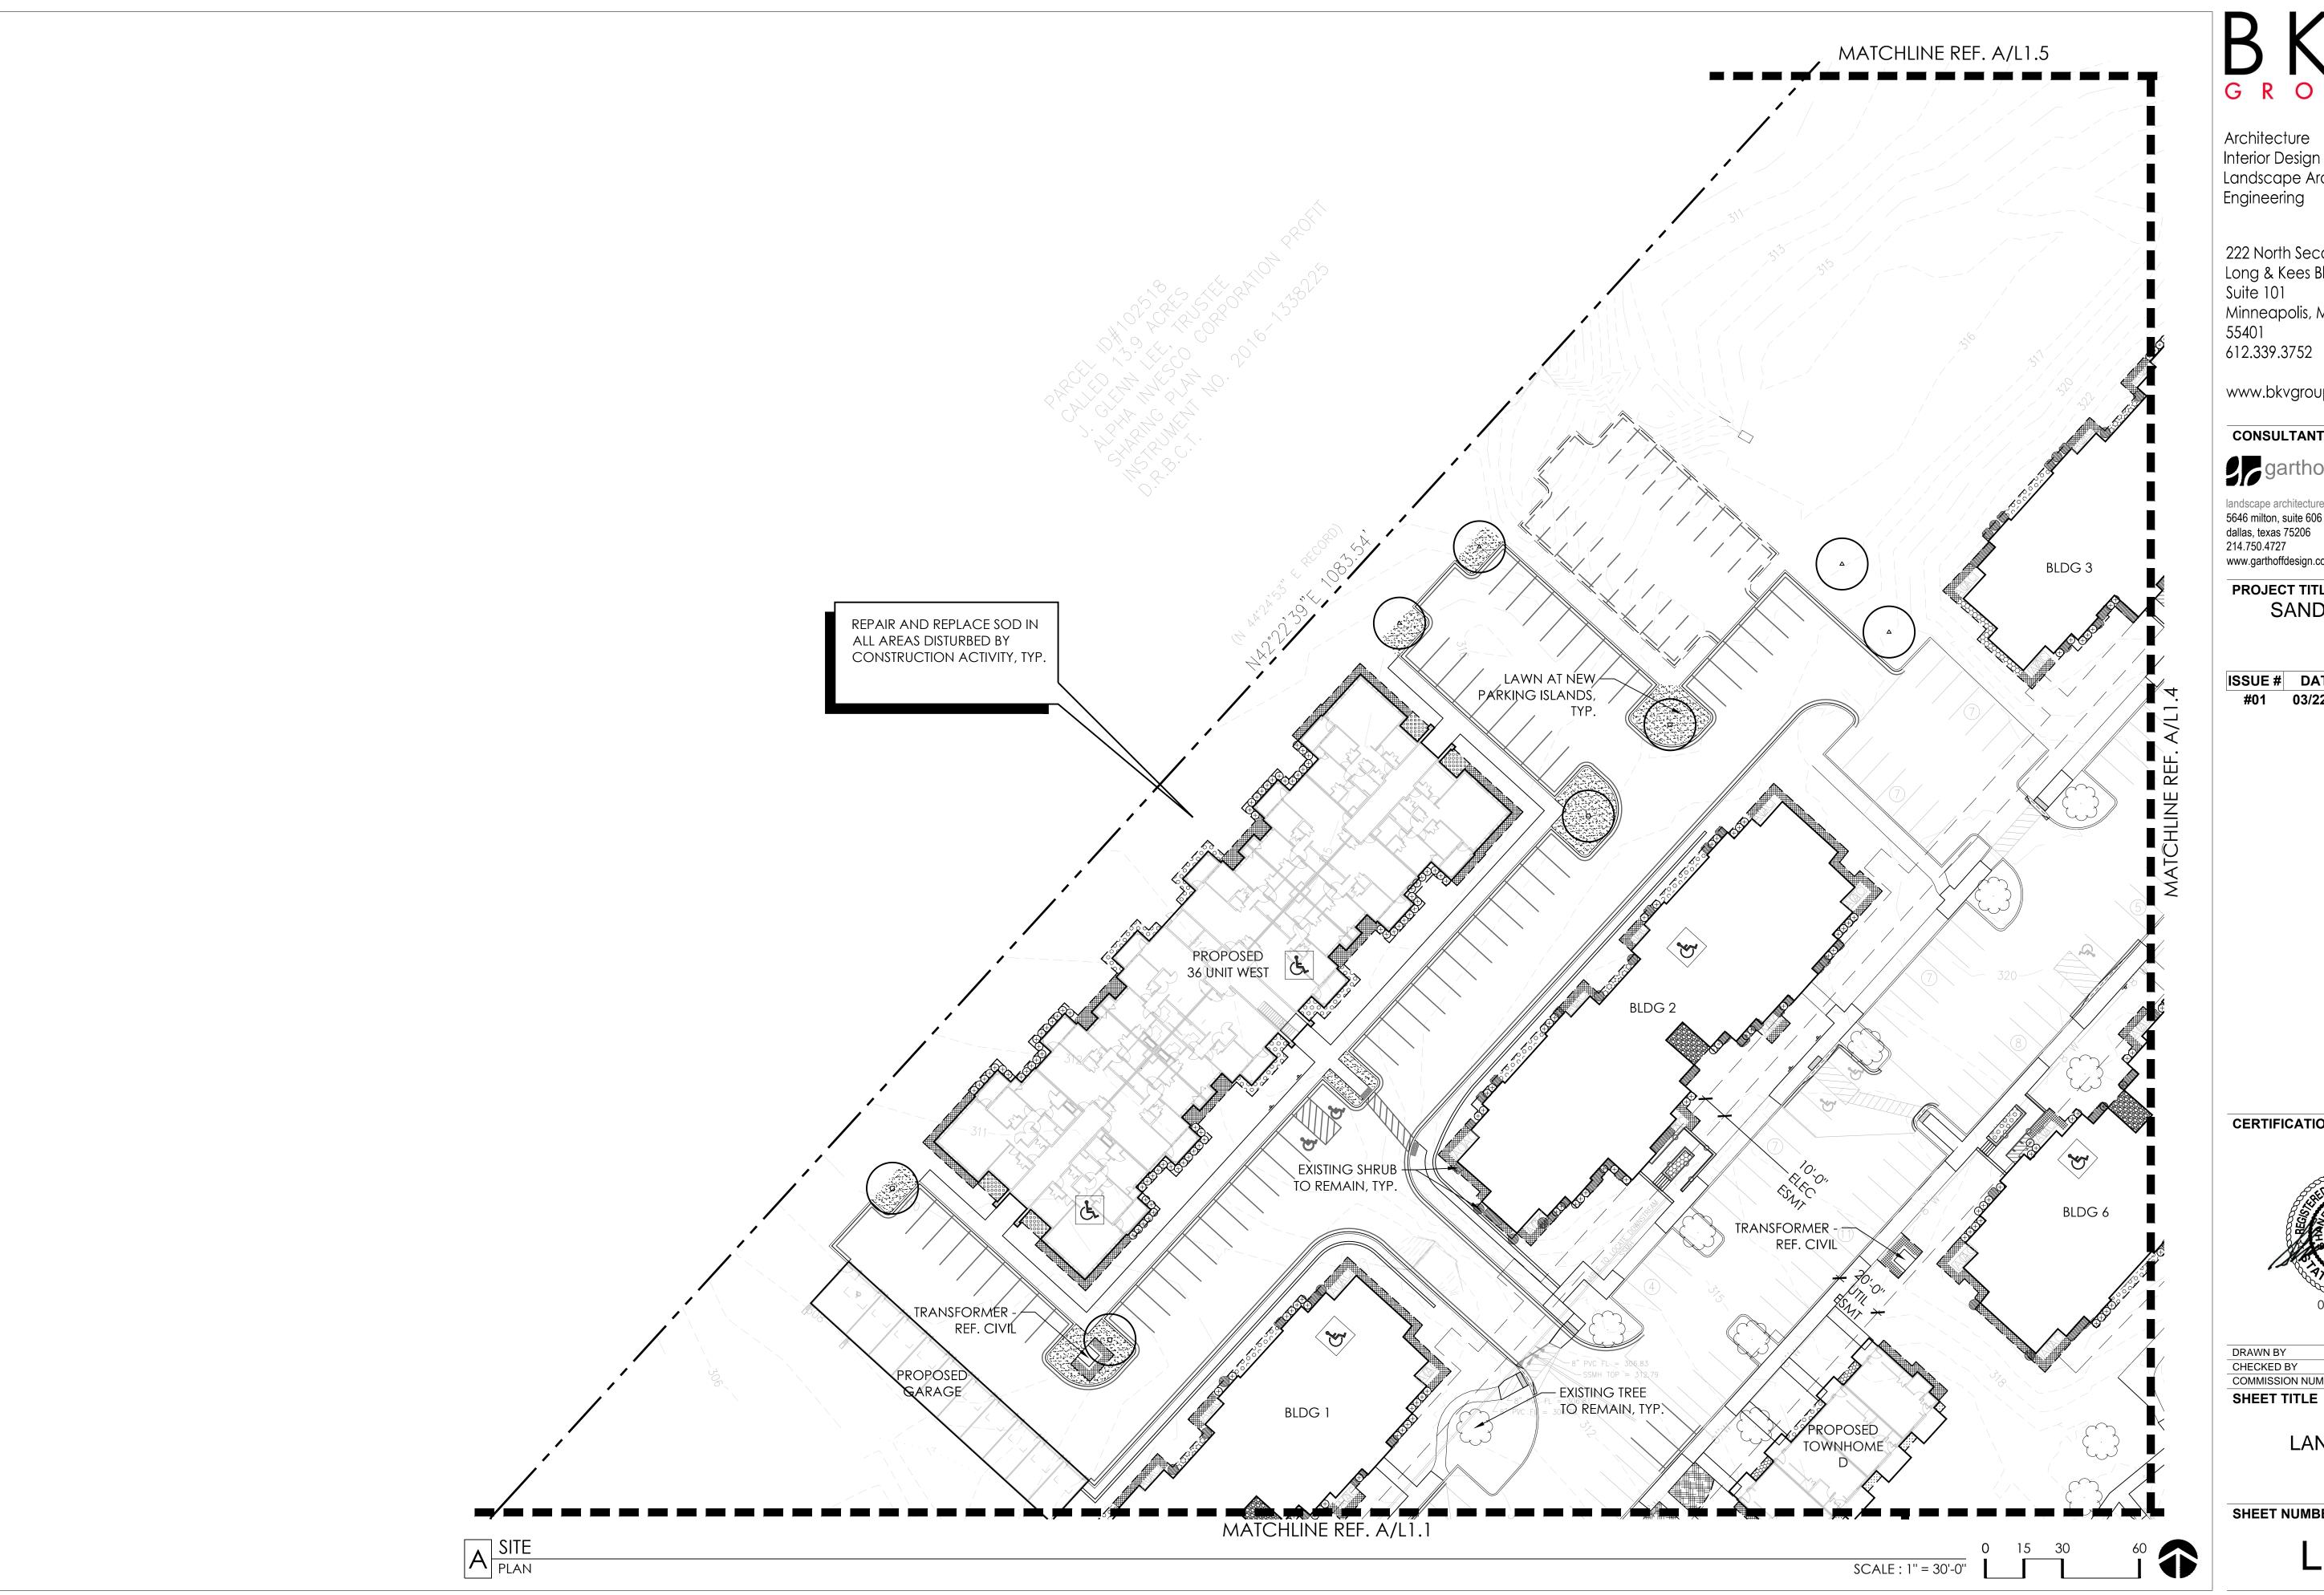


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G R O U P

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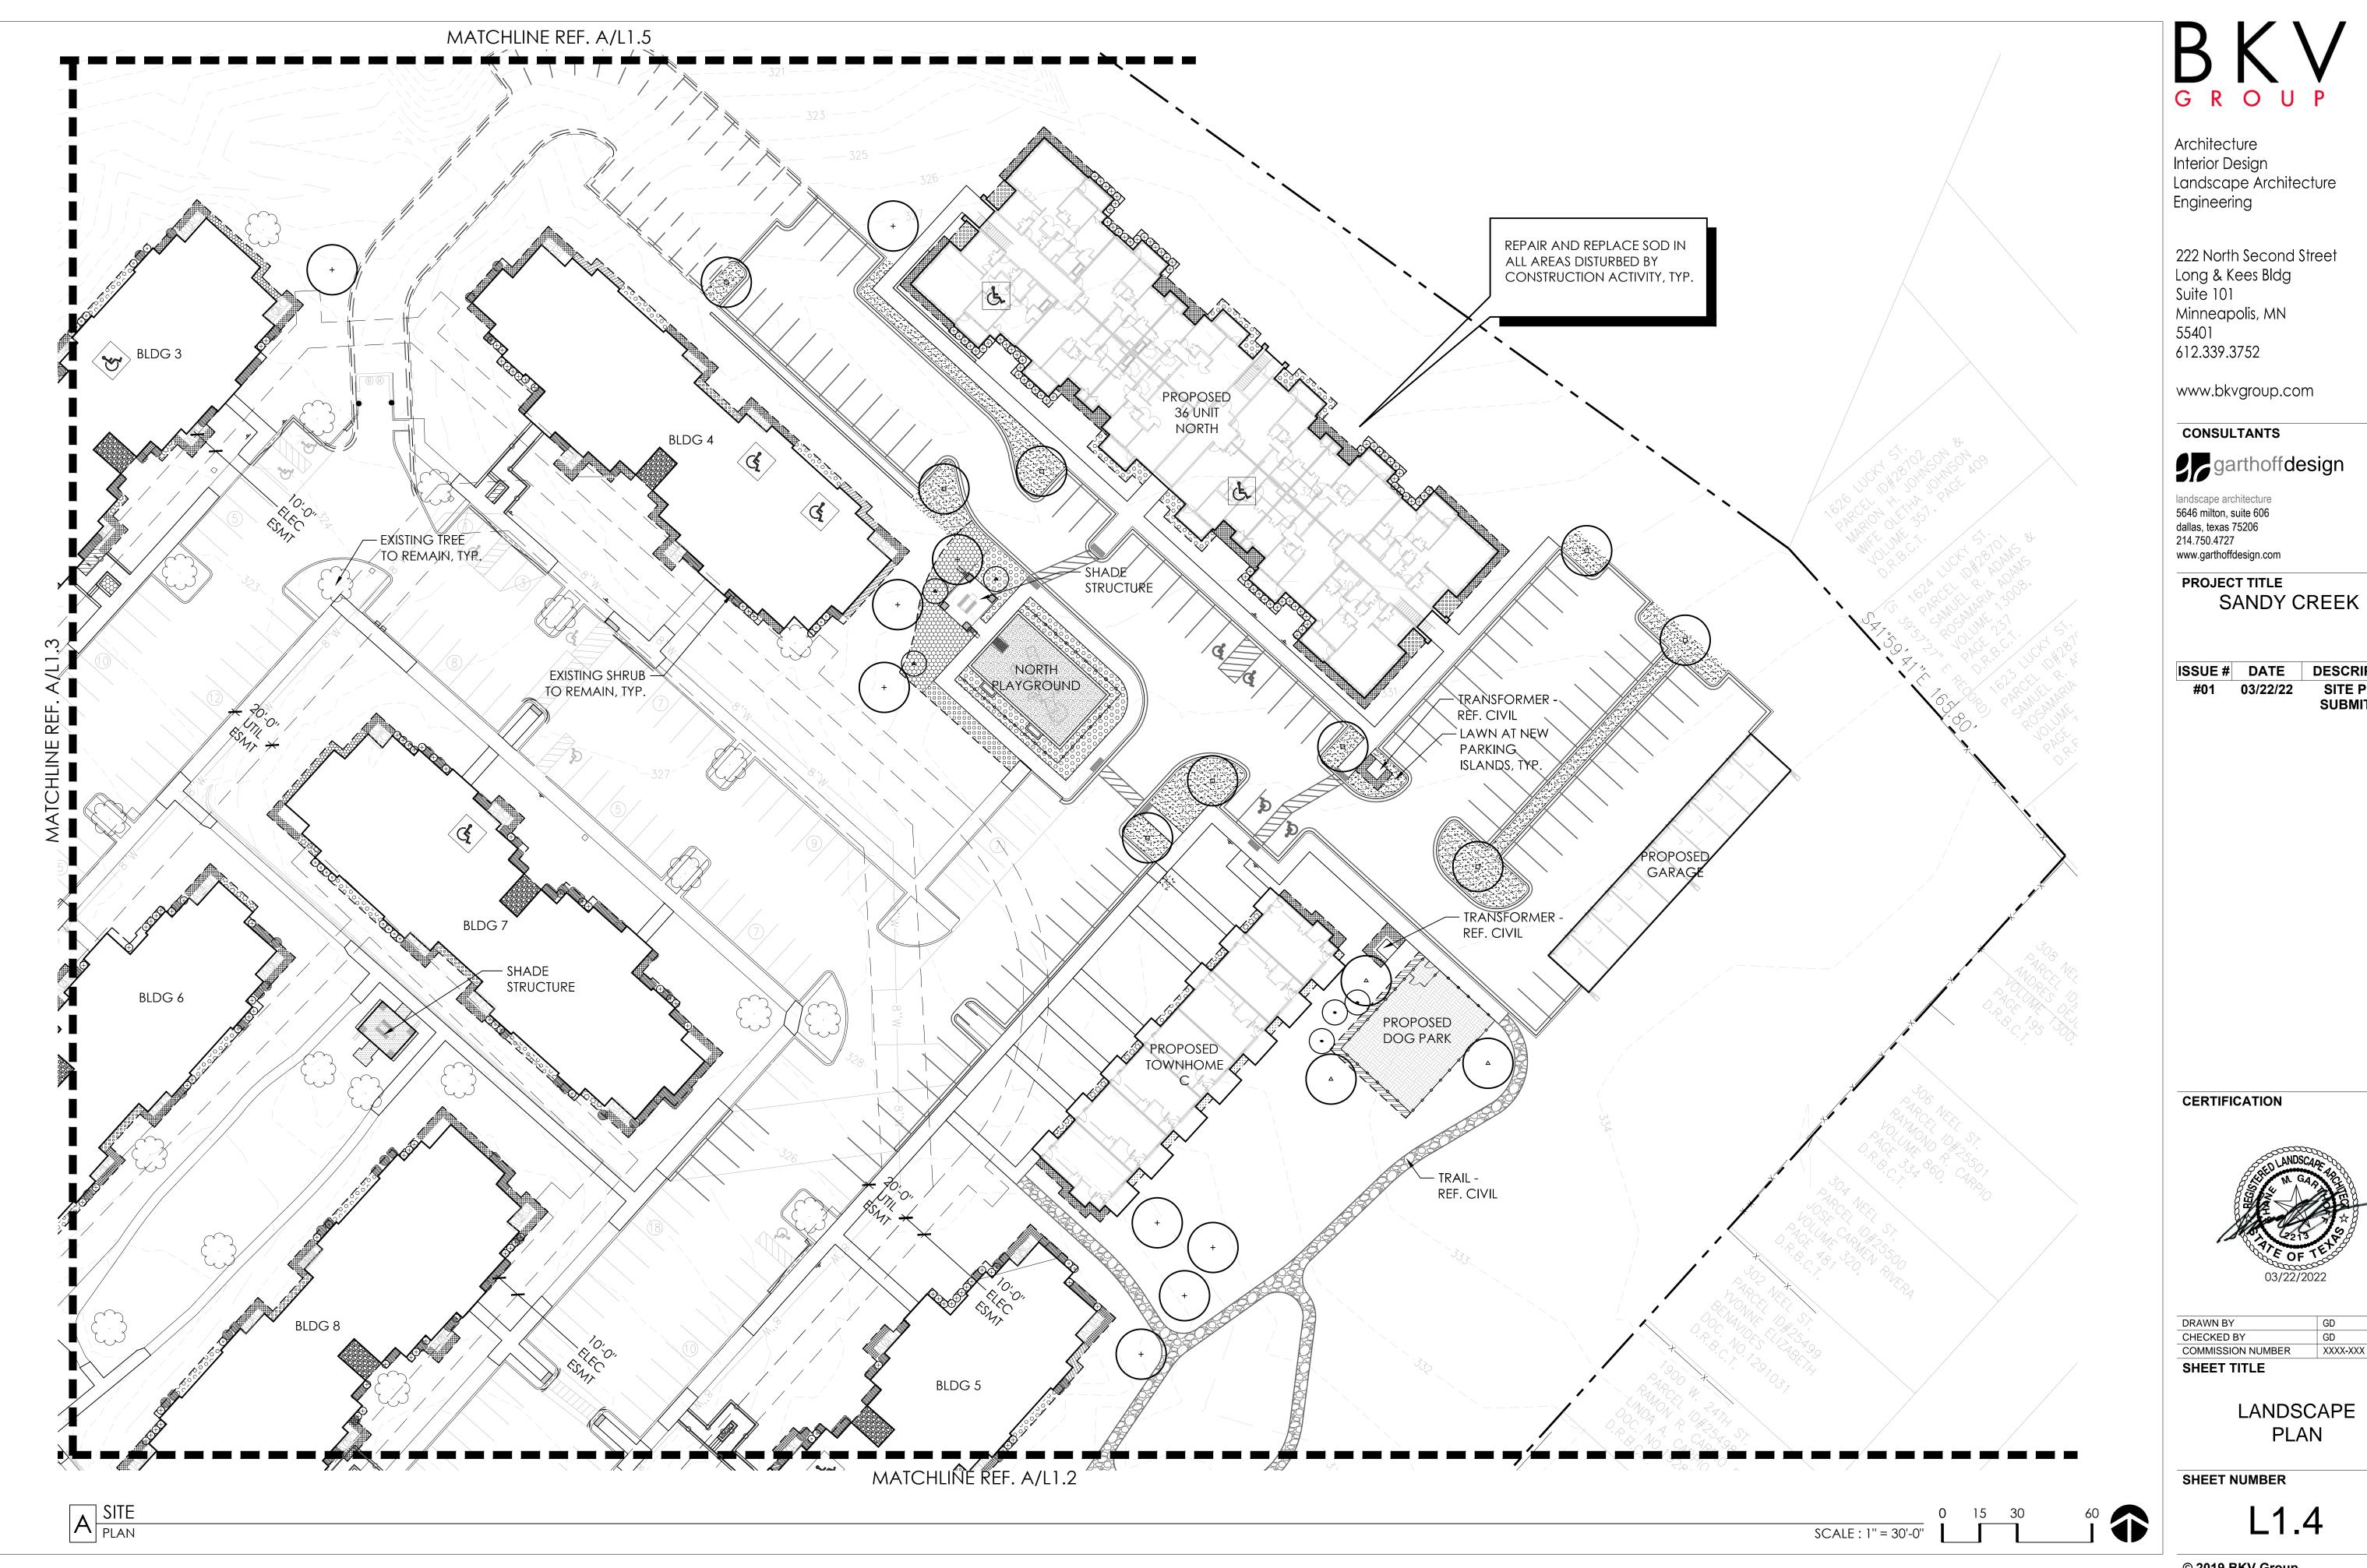


DRAWN BY CHECKED BY COMMISSION NUMBER XXXX-XXX

> LANDSCAPE PLAN

SHEET NUMBER

L1.3



Landscape Architecture



DESCRIPTION

SITE PLAN SUBMITTAL



LANDSCAPE

MATCHLINE REF. A/L1.4 MATCHLINE REF. A/L1.3

A SITE PLAN



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> LANDSCAPE PLAN

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SCALE: 1" = 30'-0"

L1.5

	EXISTING BUILDIN	IGS
CLUBHO		103
PROPOSE	ED SHRUBS:	
	AGK	8
	HP	110
	MP	7
	LCS	17
	PTW	12
BUILDING	G 1	
	SHRUBS:	30
PROPOSE	ED SHRUBS:	
	AGK	25
	HP	6
	IC	69
	IV	28
BUILDING		
	S SHRUBS:	37
PKUPOSE	ED SHRUBS:	. -
	AGK	24
	IC IV	75
	TG	33 2
BUILDING		2
	S SHRUBS:	42
	ED SHRUBS:	72
11101031	AGK	33
	HP	13
	IC	42
	IV	9
	TG	6
BUILDING	G 4	
EXISTING	S SHRUBS:	12
PROPOSE	ED SHRUBS:	
	AGK	18
	IC	84
	IV	12
	LS	28
	PTW	9
	TG	4
BUILDING	G 5	
EXISTING	S SHRUBS:	34
PROPOSE	D SHRUBS:	
	AGK	18
	IC	64
	IV	25
	LS	16
	PTW	9
BUILDING		
	S SHRUBS:	14
PROPOSE	ED SHRUBS:	
	AGK	18
	НР	11
	IC	75
	IV	38
	PTW	9
BUILDING		
	S SHRUBS:	26
PROPOSE	ED SHRUBS:	
	AGK	18
	HP	6
	IC	54
	IV	15
	PTW	8
	TG	8

SHRUB QUANTITIES BY	LOCATION
PROPOSED BUILDINGS/	AMENITIES
ENTRY / SIGN WALL	AIVIEIVITIES
PROPOSED SHRUBS:	
AGK	104
HP	170
SERVICE BUILDING	170
PROPOSED SHRUBS:	
AGK	5
LCS	6
IC	12
MP	28
SOUTH PLAYGROUND	
PROPOSED SHRUBS:	
AGK	46
MP	85
UNITS 36 WEST	
PROPOSED SHRUBS:	
AGK	60
IC	134
IV	72
PTW	32
UNITS 36 NORTH	
PROPOSED SHRUBS:	
AGK	60
IC	134
IV	72
PTW	32
TOWNHOME B	
PROPOSED SHRUBS:	
AGK	8
IC	29
IV	11
TOWNHOME C	
PROPOSED SHRUBS:	
AGK	8
HP	20
IC	29
IV	20
TOWNHOME D	
PROPOSED SHRUBS:	
AGK	7
IC	28
IV	11
NORTH PLAYGROUND	
PROPOSED SHRUBS:	
AGK	179
IV	34
DOG PARK	
PROPOSED SHRUBS:	25
MP TRANSFORMERS	28
TRANSFORMERS	CF.
IC	65 1,52 9

CITY OF BRYAN LANDSCAPING REQUIREMENTS (SEC. 62-429)

REQUIRED: 15% OF DEVELOPED AREA TO BE LANDSCAPED
PARKING AREA (219,173 SF) + BUILDING AREA (144,243 SF) = 363,416 SF
15% = 54,512 SF LANDSCAPE AREA
50% MIN. LANDSCAPE AREA TO BE CANOPY TREES = 27,256 SF

PROVIDED: 62,300 SF OF LANDSCAPE AREA
60% LANDSCAPE AREA CANOPY TREES

(23,200 SF (EXISTING CANOPY TREES) + 8,800 = 32,800 SF)
REQUIRED: SHADE OR EVERGREEN TREE PROVIDED FOR EVERY PARKING LOT END

ISLAND WITH LANDSCAPING (SHRUBS, GROUNDCOVER, LAWN)
PROVIDED: SHADE OR EVERGREEN TREE PROVIDED FOR EVERY PARKING LOT END
ISLAND WITH LANDSCAPING (SHRUBS, GROUNDCOVER, LAWN)

ACCESSORY MATERIALS NOTES:

1. FILTER FABRIC: NON-WOVEN SOIL BARRIER, MIRAFI OR APPROVED EQUAL.

2. DRAINAGE GRAVEL: CLEAN, WASHED, FREE-DRAINING, SIZE 1" -2" DIAMETER.

3. CONCRETE (FLATWORK): STEEL REINFORCED, PORTLAND CEMENT, 3000 PSI STRENGTH AT 28 DAYS.

PLANT SCHEDULE

COMMON NAME	CAL.	MIN. HEIGHT	MIN. SPREAD	CONTAINER/ ROOTBALL	SPACING	REMARKS	SF VALUE	TOTAL
LI LAGERSTROEMIA INDICA X FAURIEI 'NATCHEZ'/ NATCHEZ CRAPE MYRTLE	NA	10'	6'	45 GAL.	PER PLAN	MULTI-TRUNK, 5 CANE MIN., FULL CANOPY, MATCHED	100	1,400
QS QUERCUS SHUMARDII/ SHUMARD OAK	3"	10'	6'	65 GAL.	PER PLAN	SINGLE STRAIGHT TRUNK, FULL CANOPY, MATCHED	200	2,200
QV QUERCUS VIRGINIANA/ LIVE OAK	3"	10'	6'	65 GAL.	PER PLAN	SINGLE STRAIGHT TRUNK, FULL CANOPY, MATCHED	200	4,600
UP ULMUS PARVIFOLIA/ LACEBARK ELM	3"	10'	6'	65 GAL.	PER PLAN	SINGLE STRAIGHT TRUNK, FULL CANOPY, MATCHED	200	2,000
VA VITEX AGNUS-CASTUS/ CHASTE TREE	NA	6'	4'	45 GAL.	PER PLAN	MULTI-TRUNK, 5 CANE MIN., FULL CANOPY, MATCHED	100	1,000
	NATCHEZ CRAPE MYRTLE QS QUERCUS SHUMARDII/ SHUMARD OAK QV QUERCUS VIRGINIANA/ LIVE OAK UP ULMUS PARVIFOLIA/ LACEBARK ELM VA VITEX AGNUS-CASTUS/	NATCHEZ CRAPE MYRTLE QS QUERCUS SHUMARDII/ SHUMARD OAK QV QUERCUS VIRGINIANA/ LIVE OAK UP ULMUS PARVIFOLIA/ LACEBARK ELM VA VITEX AGNUS-CASTUS/ NA	NATCHEZ CRAPE MYRTLE QS QUERCUS SHUMARDII/ SHUMARD OAK QV QUERCUS VIRGINIANA/ LIVE OAK UP ULMUS PARVIFOLIA/ LACEBARK ELM VA VITEX AGNUS-CASTUS/ NA 6'	NATCHEZ CRAPE MYRTLE QS QUERCUS SHUMARDII/ SHUMARD OAK QV QUERCUS VIRGINIANA/ LIVE OAK UP ULMUS PARVIFOLIA/ LACEBARK ELM VA VITEX AGNUS-CASTUS/ NA 6' 4'	NATCHEZ CRAPE MYRTLE 3" 10' 6' 65 GAL.	NATCHEZ CRAPE MYRTLE QS QUERCUS SHUMARDII/ SHUMARD OAK 3" 10' 6' 65 GAL. PER PLAN QV QUERCUS VIRGINIANA/ LIVE OAK UP ULMUS PARVIFOLIA/ LACEBARK ELM VA VITEX AGNUS-CASTUS/ NA 6' 4' 45 GAL. PER PLAN	NATCHEZ CRAPE MYRTLE QS QUERCUS SHUMARDII/ SHUMARD OAK 3" 10' 6' 65 GAL. PER PLAN SINGLE STRAIGHT TRUNK, FULL CANOPY, MATCHED QV QUERCUS VIRGINIANA/ LIVE OAK 10' 6' 65 GAL. PER PLAN SINGLE STRAIGHT TRUNK, FULL CANOPY, MATCHED UP ULMUS PARVIFOLIA/ LACEBARK ELM VA VITEX AGNUS-CASTUS/ NA 6' 4' 45 GAL. PER PLAN MULTI-TRUNK, 5 CANE MIN.,	NATCHEZ CRAPE MYRTLE QS QUERCUS SHUMARDII/ SHUMARD OAK 3" 10' 6' 65 GAL. PER PLAN SINGLE STRAIGHT TRUNK, FULL CANOPY, MATCHED 200 QV QUERCUS VIRGINIANA/ LIVE OAK 3" 10' 6' 65 GAL. PER PLAN SINGLE STRAIGHT TRUNK, FULL CANOPY, MATCHED 200 UP ULMUS PARVIFOLIA/ LACEBARK ELM 3" 10' 6' 65 GAL. PER PLAN SINGLE STRAIGHT TRUNK, FULL CANOPY, MATCHED 200 VA VITEX AGNUS-CASTUS/ NA 6' 4' 45 GAL. PER PLAN MULTI-TRUNK, 5 CANE MIN., 100

			SES / GROUNDCOVERS							
		AD	ASPARAGUS DENSIFLORUS 'MYERS'/ FOXTAIL FERN	12"	12"	1 GAL.	24" O.C.			
**************************************	639	AGK	ABELIA X GRANDIFLORA 'KALEIDOSCOPE'/ KALEIDOSCOPE ABELIA	24"	24"	5 GAL.	36" O.C.		10	6,390
		BG	BOUTELOUA GRACILIS 'BLONDE AMBITION PP#22049/ BLONDE AMBITION BLUE GRAMA	12"	12"	1 GAL.	18" O.C.			
		EF	EUONYMUS FORTUNEI 'COLORATUS'/ PURPLE WINTERCREEPER	6"	12"	4" POTS	12" O.C.	FULL ROOTED POTS, VIGOROUS GROWTH AT TIME OF PLANTING		
	336	HP	HERPERALOE PARVIFLORE 'PERPA' PP 21,729/ BRAKELIGHTS YUCCA	24"	24"	5 GAL.	36" O.C.		10	3,360
	894	IC	ILEX CORNUTA 'DWARF BURFORD'/ DWARF BURFORD HOLLY	24"	24"	5 GAL.	36" O.C.		10	8,940
\oplus	380	IV	ILEX VOMITORIA 'NANA'/ DWARF YAUPON HOLLY	18"	18"	5 GAL.	36" O.C.		10	3,800
		JT	JUNCUS TENIUS 'BLUE DART'/ BLUE DART RUSH	12"	12"	1 GAL.	24" O.C.			
	44	LS	LIGUSTRUM SINENSE 'SUNSHINE' PP 20379/ SUNSHINE LIGUSTRUM	24"	24"	5 GAL.	36" O.C.		10	440
•	23	LCS	LOROPETALUM CHINENSE 'SHANG-HI'/ PURPLE DIAMOND FRINGE FLOWER	24"	24"	5 GAL.	36" O.C.		10	230
# # #		LM	LIRIOPE MUSCARI 'BIG BLUE'/ BIG BLUE LILY TURF	12"	12"	4" POTS	12" O.C.	FULL ROOTED POTS, VIGOROUS GROWTH AT TIME OF PLANTING		
		MC	MUHLENBERGIA CAPILLARIS 'REGAL MIST'/ REGAL MIST GULF MUHLY	18"	18"	1 GAL.	36" O.C.			
	148	MP	MYRICA PUSILLA/ DWARF WAX MYRTLE	24"	24"	5 GAL.	36" O.C.		10	1,480
	111	PTW	PITTOSPORUM TOBIRA 'WHEELER'S DWARF'/ WHEELER'S DWARF PITTOSPORUM	18"	24"	5 GAL.	36" O.C.		10	1,110
		SC	SEASONAL COLOR	12"	12"	4" POTS	12" O.C.	FULL ROOTED POTS, VIGOROUS GROWTH AT TIME OF PLANTING		
		SG	SALVIA GREGGII/ AUTUMN SAGE	18"	18"	1 GAL.	24" O.C.			
0	20	TG	TERNSTROEMIA GYMNANTHERA/ CLEYERA	24"	24"	5 GAL.	36" O.C.		10	200

	CYNADON DACTYLON, COMMON BERMUDAG			SOLID SOD AS DESIGNATED ON PLANS	
ACCESSO	PRIES				
SYMBOL	DESCRIPTION	COLOR	FINISH	REMARKS	
E.1	4" X 3/16" STEEL EDGE	GRAY/METALLIC	GALVANIZED		
G.1	STABILIZED DECOMPOSED GRANITE	NATURAL, PINK/BROWN	NATURAL		
MATERIALS SCHEDULE					

			.,,,,,,,,,,,,,,,,,,,,,,,,,,,,,,,,,,,,,,	120 001125 022	
CONC	RETE				
SYMBOL	DESCRIPTION	COLOR	FINISH	REMARKS	SUBMITTALS / SAMPLES / MOCK-UPS
(C.1)	FLATWORK: INTEGRAL COLOR	TBD	SANDBLAST		PROVIDE MIN. 2' X 2' MOCKUP SHOWING COLOR AND FINISH FOR UP TO THREE (3) COLORS
C.2	FLATWORK	STANDARD PORTLAND GRAY	MEDIUM SANDBLAST	REF. PLANS FOR LOCATIONS & CIVIL FOR DETAILS	PROVIDE MIN. 2' X 2' MOCKUP SHOWING COLOR AND FINISH FOR UP TO THREE (3) COLORS



Architecture
Interior Design
Landscape Architecture
Engineering

222 North Second Street Long & Kees Bldg Suite 101 Minneapolis, MN 55401 612.339.3752

www.bkvgroup.com

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landscape architecture 5646 milton, suite 606 dallas, texas 75206 214.750.4727 www.garthoffdesign.com

PROJECT TITLE
SANDY CREEK

ISSUE #	DATE	DESCRIPTION
#01	03/22/22	SITE PLAN
		SUBMITTAL

CERTIFICATION

TOTAL PROPOSED AREA PROVIDED

TOTAL LANDSCAPE AREA PROVIDED

62,300

TOTAL (58) EXISTING TREES AREA PROVIDED

TOTAL EXISTING SHRUBS (195) AREA PROVIDED




DRAWN BY
CHECKED BY
COMMISSION NUMBER
XXXX-XXX
SHEET TITLE

LANDSCAPE CITY CODE & SCHEDULE

SHEET NUMBER

L1.6

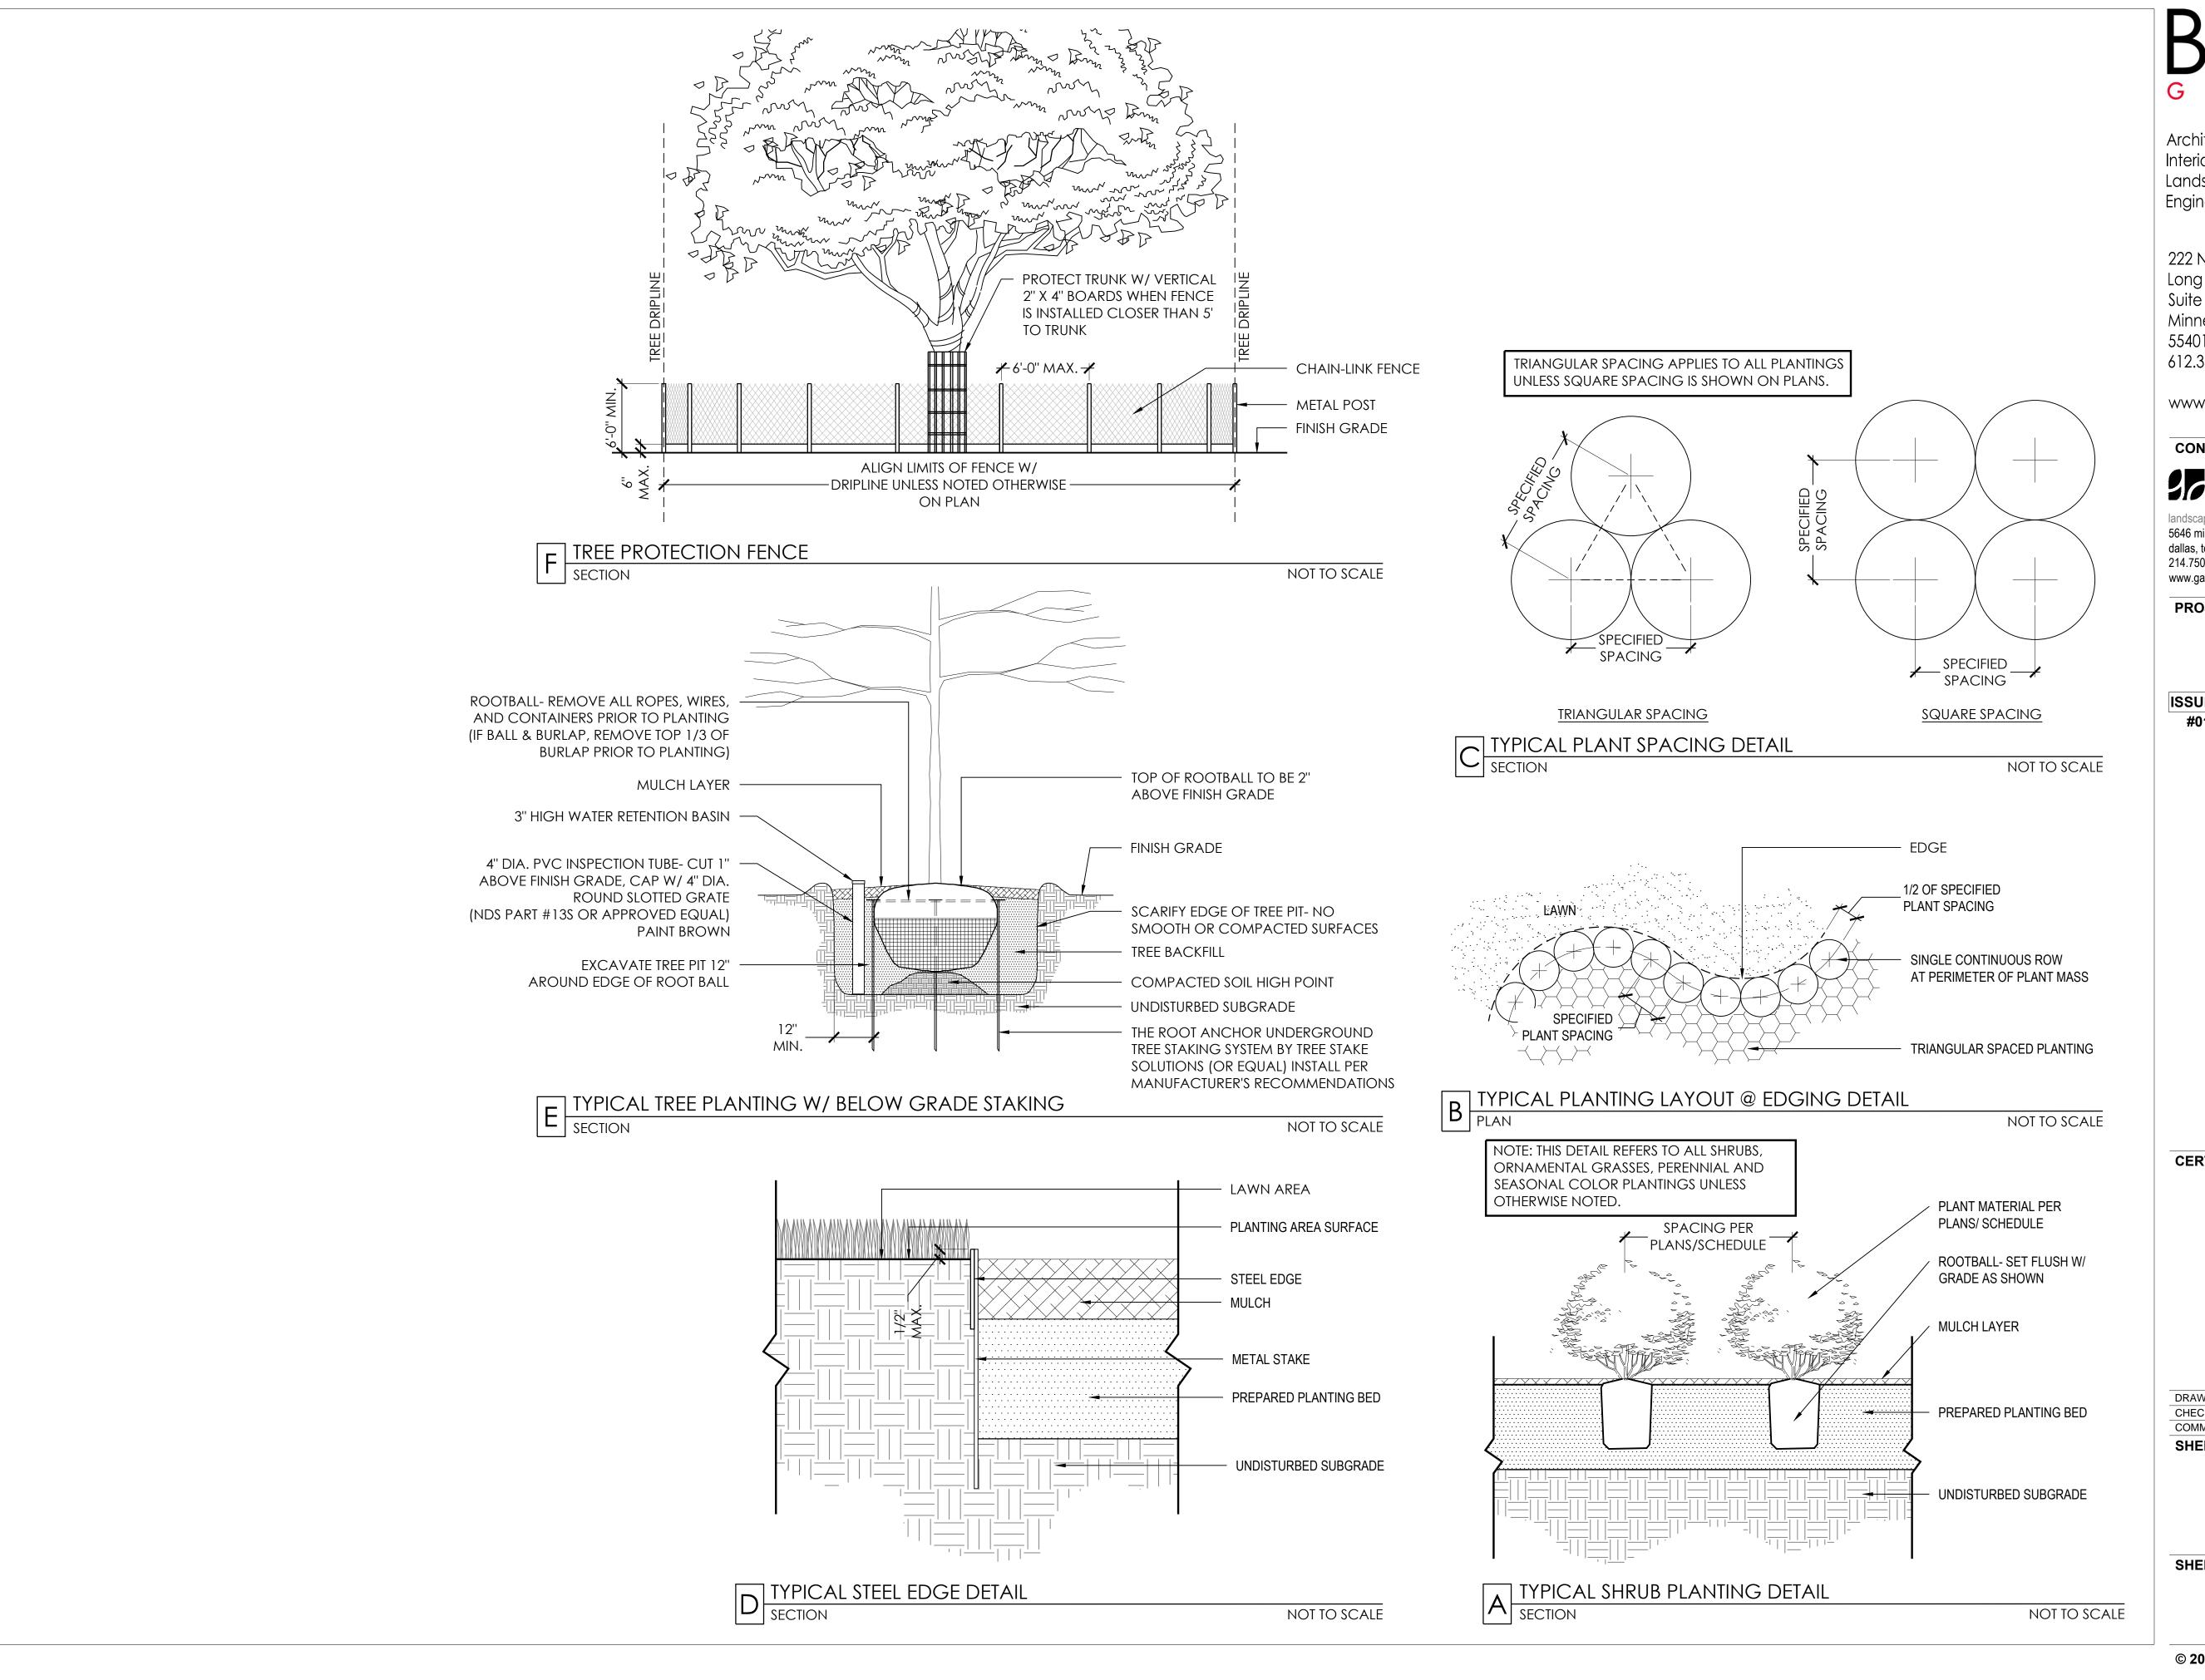

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PROJECT TITLE
SANDY CREEK

#01 03/22/22 SITE PLAN SUBMITTAL

CERTIFICATION



DRAWN BY GD
CHECKED BY GD
COMMISSION NUMBER XXXX-XXX
SHEET TITLE

LANDSCAPE DETAILS

SHEET NUMBER

L1.7



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PROJECT TITLE

SANDY CREEK

ISSUE # DATE **DESCRIPTION**

SITE PLAN SUBMITTAL #01 03/22/22



CHECKED BY COMMISSION NUMBER

TREE PLAN

XXXX-XXX

SHEET NUMBER

TP1.1